

ADDENDUM 2

NORTHWOOD ELEMENTARY SCHOOL - ROOF REPLACEMENT PROJECT BUILDINGS 100, 200, 300, 400 & 500

Bid No. B-11-2022-23

December 13, 2022

BERRYESSA UNION SCHOOL DISTRICT SAN JOSE, CALIFORNIA

This Addendum forms a part of the Contract Documents. Bidders must acknowledge receipt of this Addendum in the space provided on the Bid Form. Failure to do so may subject the Bidder to disqualification.

GENERAL INFORMATION:

NONE

SPECIFICATION CLARIFICATIONS:

Item 1: Bid Bond Form - Document 00 43 13

Replace existing bid bond form with the attached bid bond form labeled addendum 2

Plan Clarifications

Item 2: Plan Sheet A2.1

Replace the existing plan sheet in its entirety with the attached plan sheet labeled addendum #2.

Item 3: Plan Sheet A2.2

Replace the existing plan sheet in its entirety with the attached plan sheet labeled addendum #2.

Item 4: Plan Sheet A10.40

Replace the existing plan sheet in its entirety with the attached plan sheet labeled addendum #2.

Attachments:

Document 00 43 13 - Bid Bond Form - (2 pages)

Plan sheet - A2.1

Plan sheet - A2.2


Plan sheet - A10.40

DOCUMENT 00 43 13

BID BOND

KNOW ALL MEN BY THESE PRESENTS that we the undersigned as Principal and as
Surety, are hereby held and firmly bound unto the Berryessa Union School District ("Owner") in the sum of Dollars (\$) for payment of which sum, well and truly to be made, we hereby jointly and severally bind ourselves, our heirs, executors, administrators, successors and assigns.
The condition of the above obligation is such that whereas the Principal has submitted to the Owner a certain bid, attached hereto and hereby made a part hereof, to enter into a Contract in writing for the construction of – Northwood Roof Replacement – Buildings 100, 200, 300, 400 & 500 in strict accordance with Contract Documents.
NOW, THEREFORE,
a. If said bid shall be rejected, or, in the alternative;
b. If said bid shall be accepted and the Principal shall execute and deliver a contract in the form of agreement attached hereto and shall execute and deliver Performance and Payment Bonds in the forms attached hereto (all properly completed in accordance with said bid), and shall in all other respects perform the agreement created by the acceptance of said bid;
Then this obligation shall be void, otherwise the same shall remain in full force and effect, it being expressly understood and agreed that the liability of the Surety for any and all default of the Principal hereunder shall be the amount of this obligation as herein stated.
Surety, for value received, hereby stipulates and agrees that no change, extension of time, alteration or addition to the terms of the Contract on the call for bids, or to the Work to be performed hereunder, or the specifications accompanying the same, shall in any way affect its obligation under this bond, and it does hereby waive notice of any such change, extension of time, alteration or addition to the terms of said Contract or the call for bids, or to the Work, or to the specifications.
IN WITNESS WHEREOF, the above-bounden parties have executed this instrument under several seals this day of, 201, the name and corporate party being hereto affixed and these presents duly signed by its undersigned representative, pursuant to authority of its governing body. In the presence of:

(Notary Seal)	
	(Principal)
	(Business Address)
	(Corporate Surety)
	Business Address)
	By:
The rate or premium of this bond is amount of premium charged, \$	per thousand, the total
(The above must be filled	d in by Corporate Surety).
END OI	FDOCUMENT

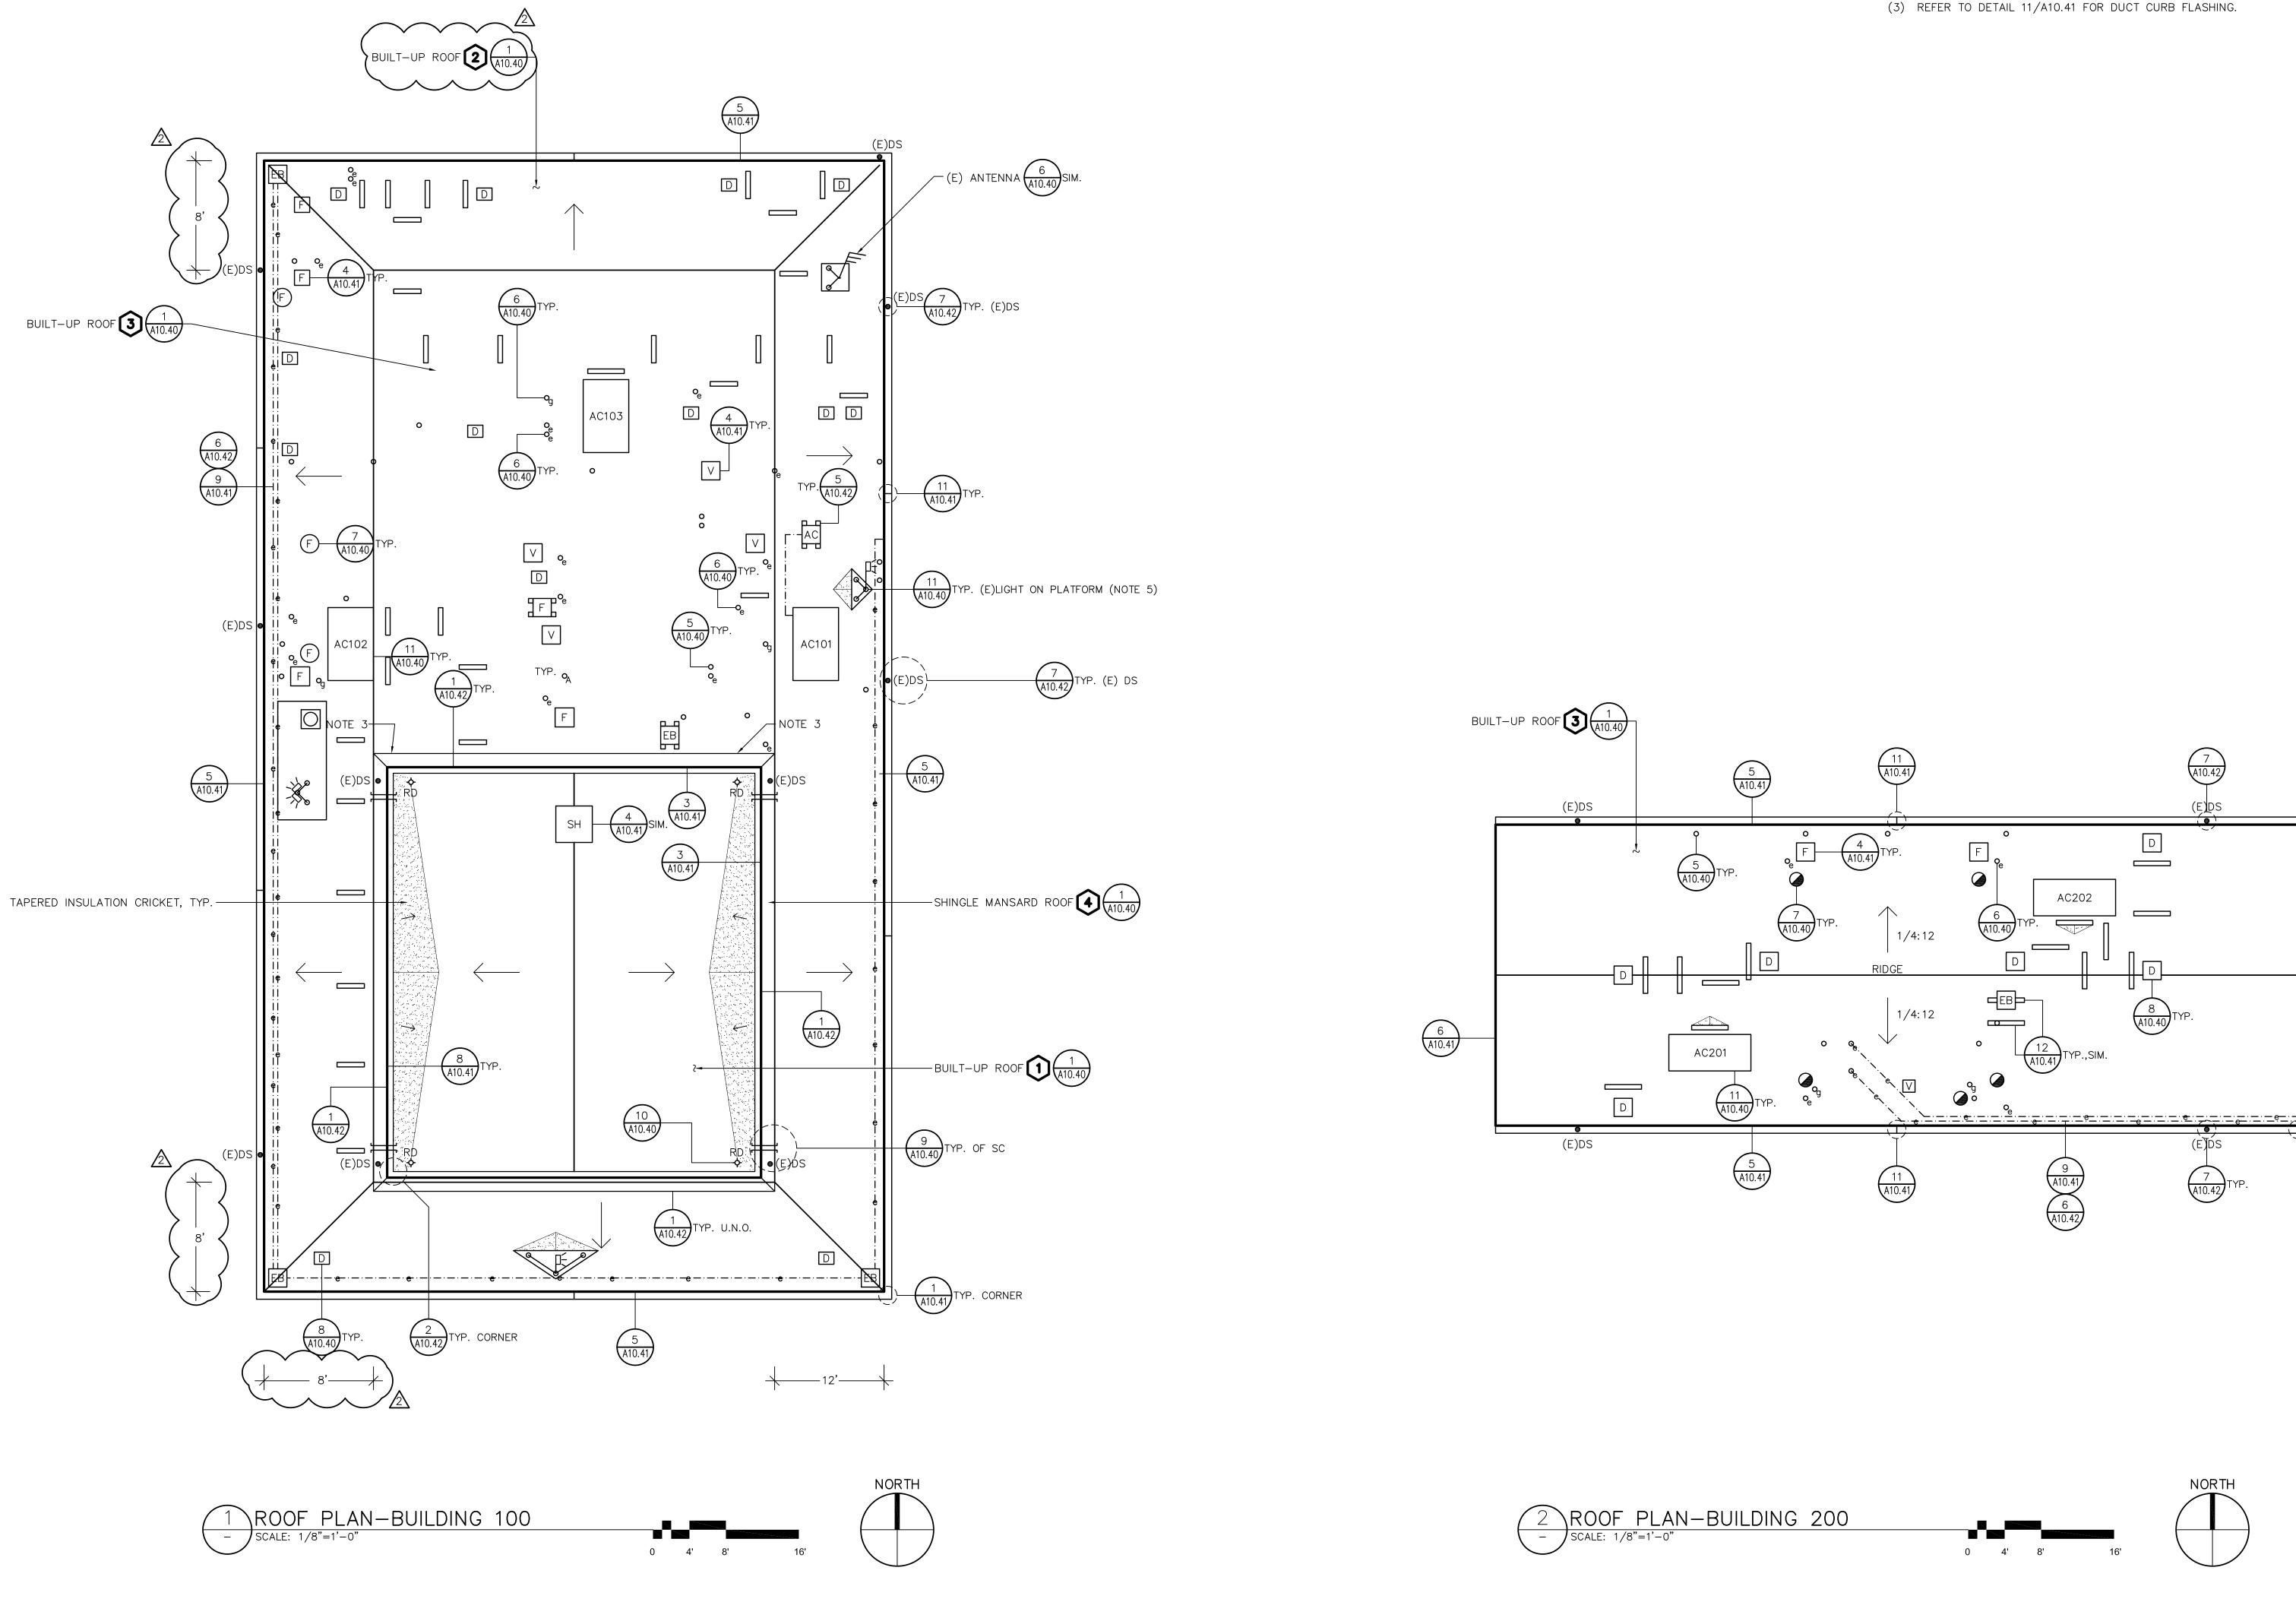

(1) REMOVE AND REINSTALL SHEET METAL AS REQUIRED TO INSTALL EDGE METAL. SET COVER FASTENERS IN SEALANT.
(2) INSTALL GSM DIVERTER AT MANSARD/DUCT INTERFACE (2 LOCATIONS).
(3) REFER TO DETAIL 11/A10.41 FOR DUCT CURB FLASHING.

Steelhead Engineers, Inc. Consulting+Design

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2	12/13/22	А	DDENDUM 2	EY
Λ	12/5/22	Д	DDENDUM 1	EY
	3/16/22	F	REVIEW SET	EY
NO.	DATE		ESCRIPTION	ВУ
PRC	JECT NO.		21043	
CAD	D FILE			
DESIGNED BY			AEB	
DRAWN BY			EY	
CHECKED BY				
DAT	E		15 OCT 2021	

ROOF PLANS BUILDINGS 100 AND 200


DRAWING SCALE AS NOTED


SHEET TITLE

A2.1

DRAWING NO.

OF

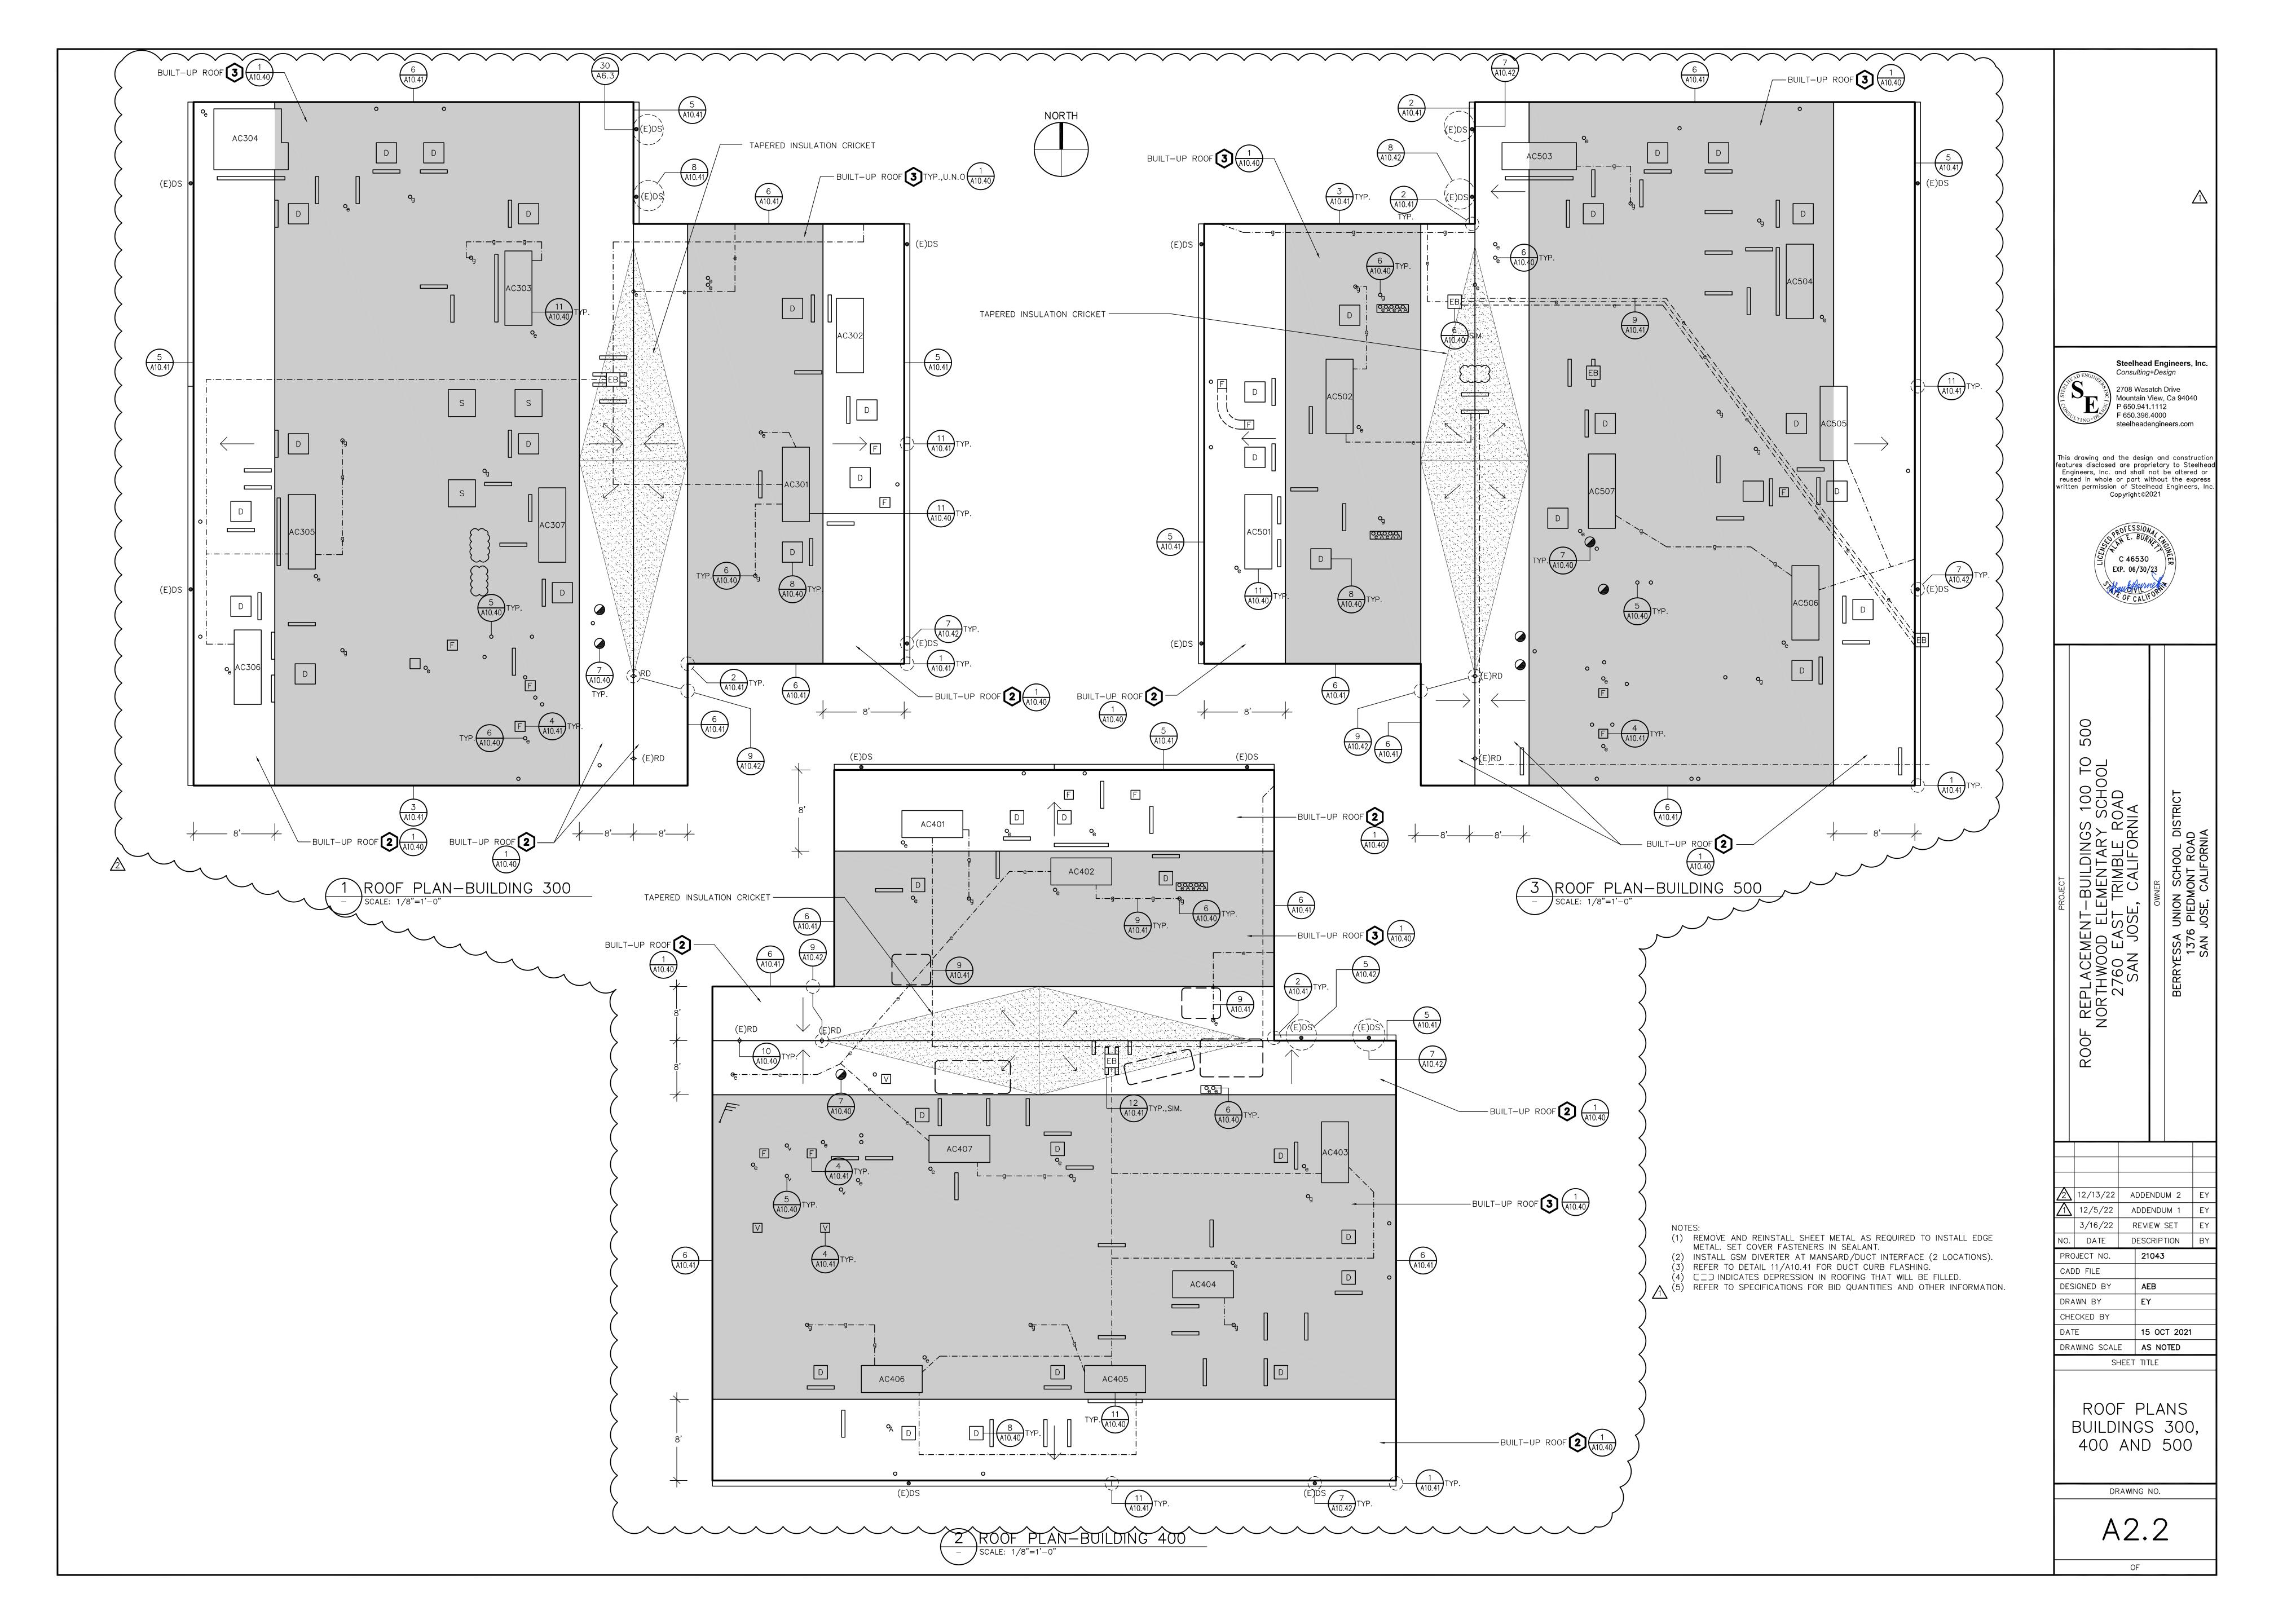

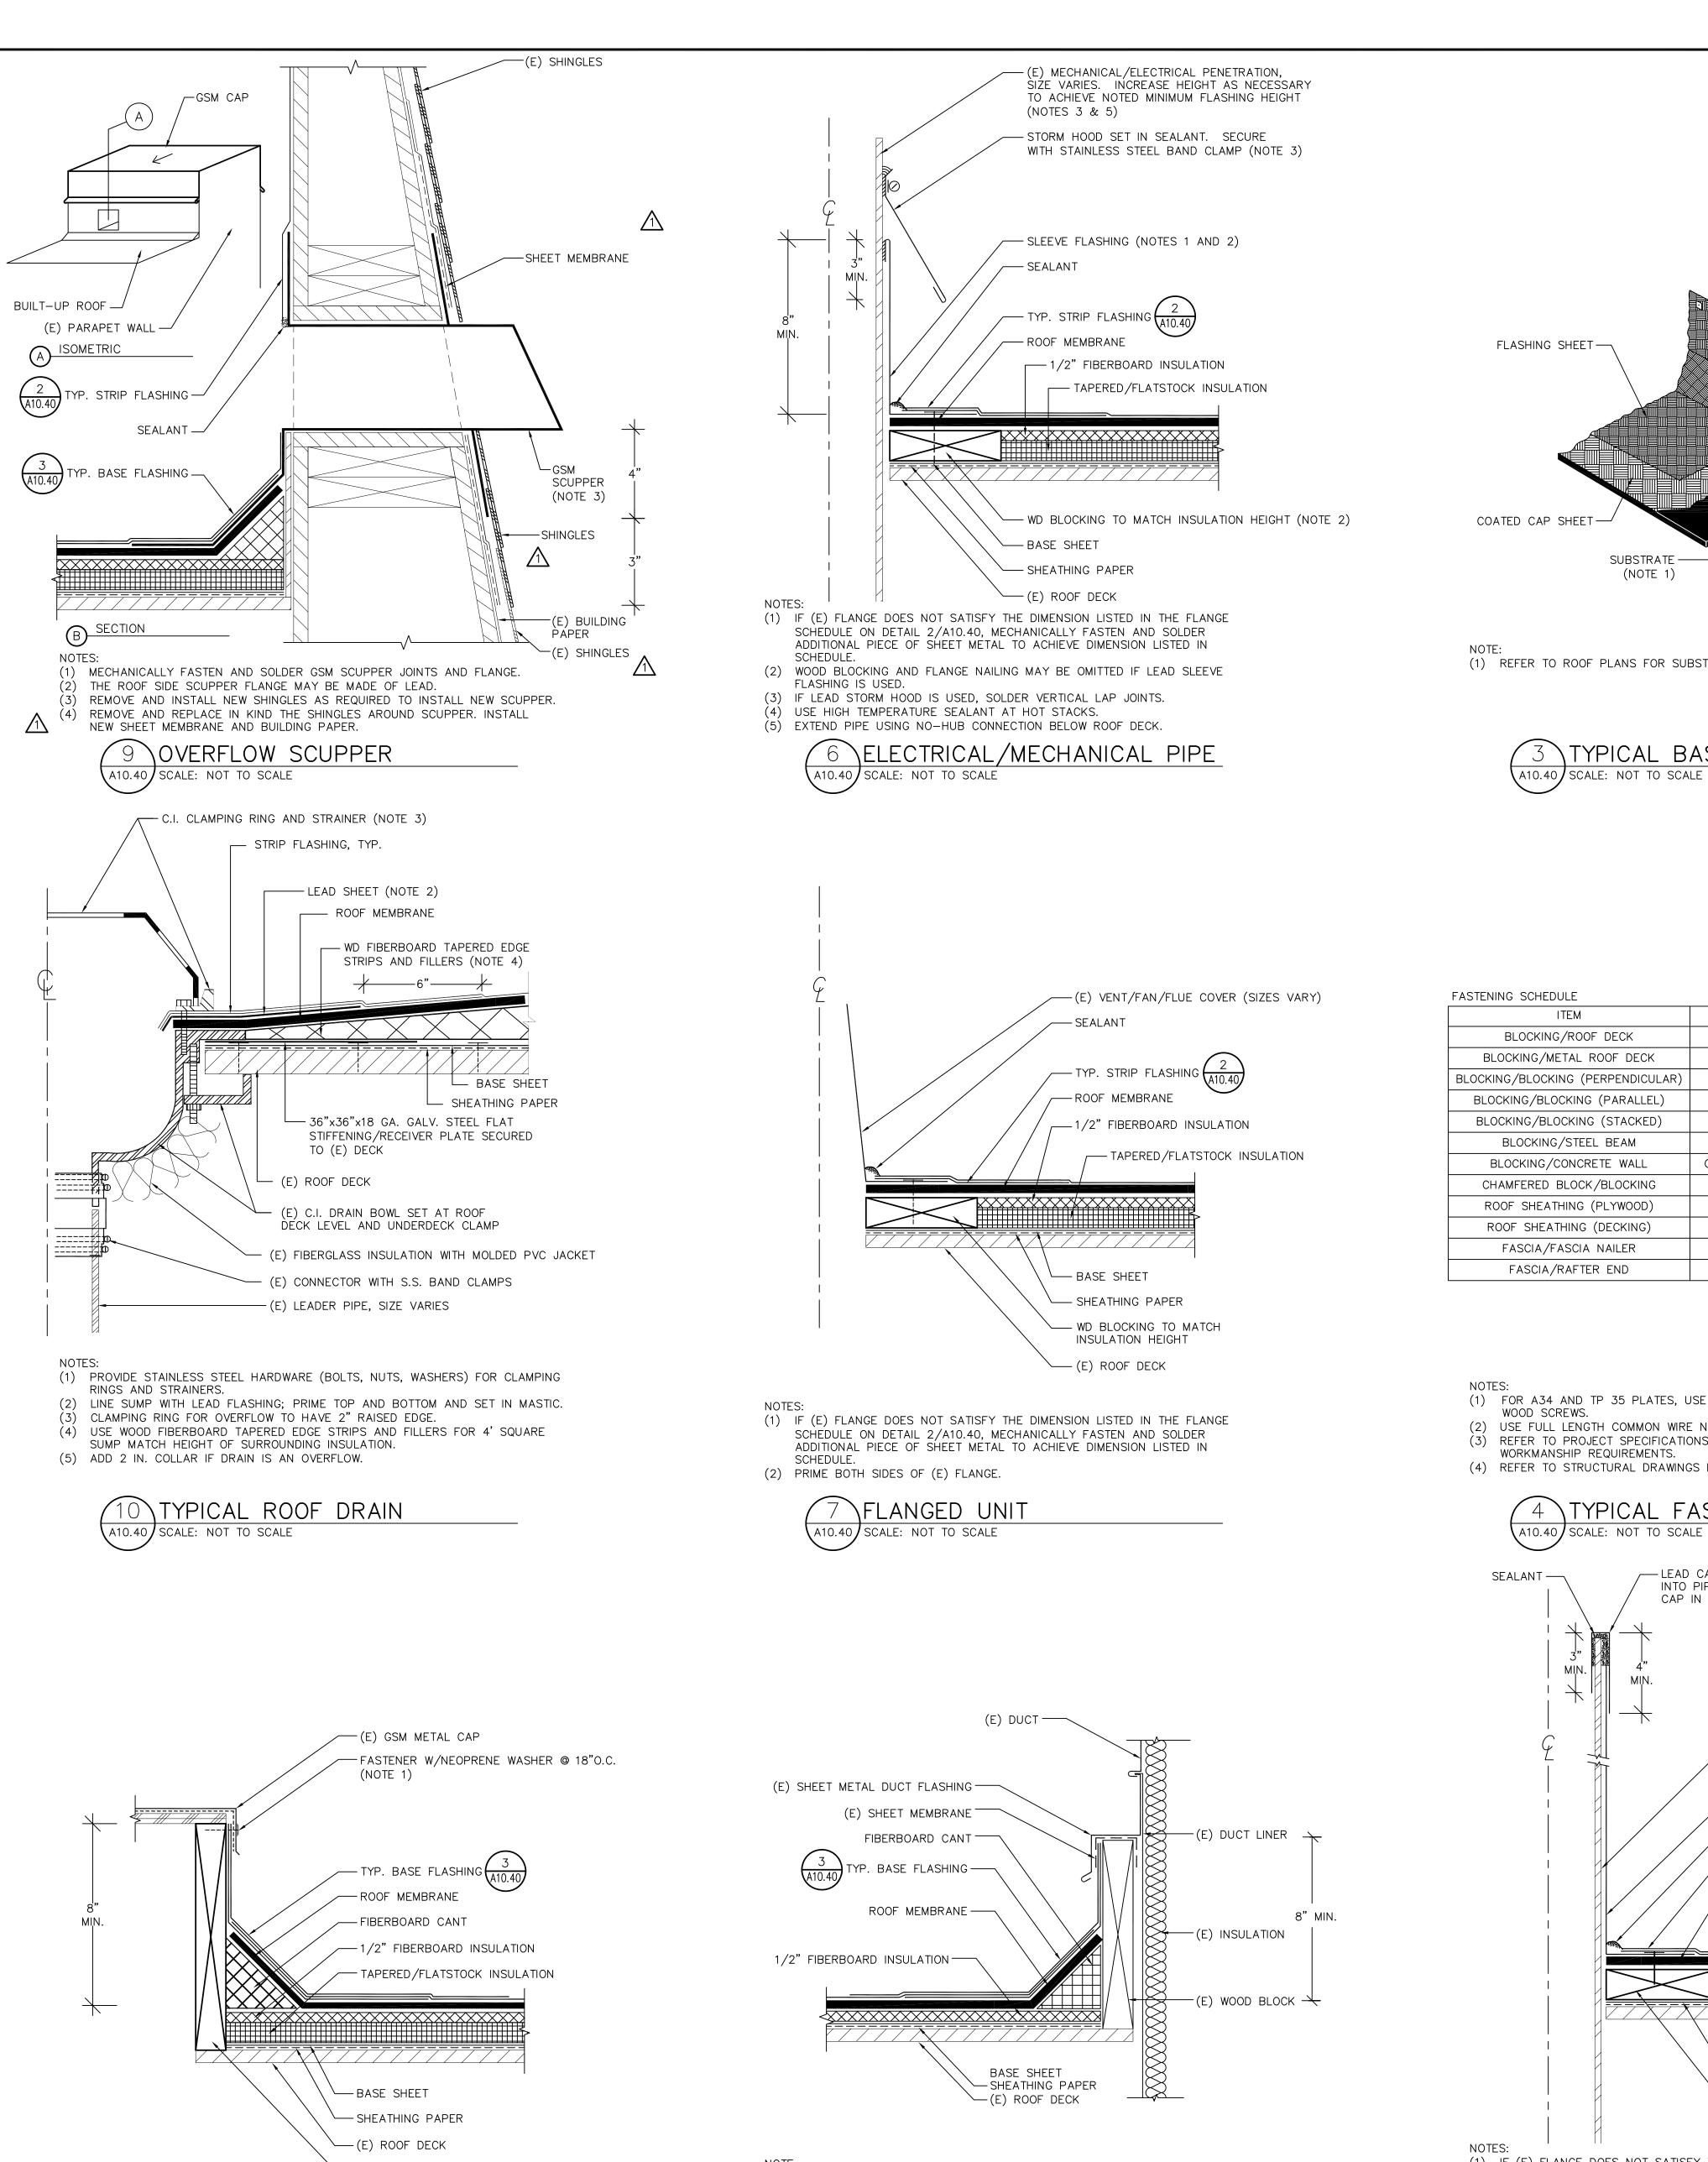

(1) REMOVE (E) FASTENERS AND LIFT SHEET METAL EDGE AS REQUIRED TO INSTALL

8 DUCT CURB


A10.40 SCALE: NOT TO SCALE

— FRAMING

(1) REMOVE (E) FASTENERS AND LIFT SHEET METAL EDGE AS REQUIRED TO INSTALL

11 MECHANICAL UNIT PLATFORM

A10.40 SCALE: NOT TO SCALE

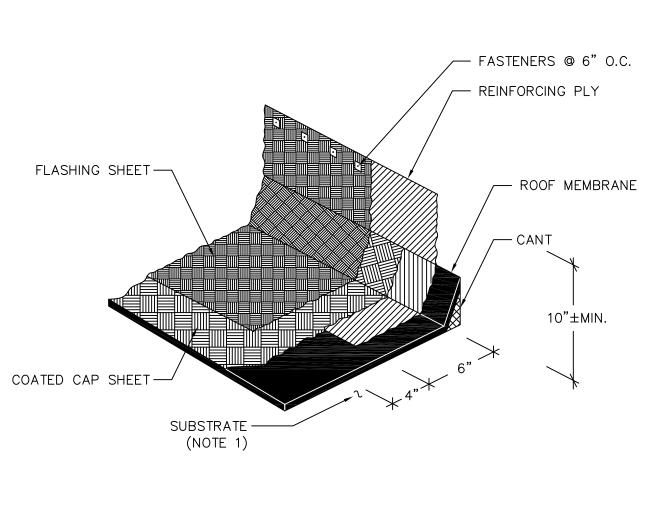

(1) REFER TO ROOF PLANS FOR SUBSTRATE TYPE.

TYPICAL BASE FLASHING SCALE: NOT TO SCALE

ITEM	FASTENER & SPACING	COMMENTS
BLOCKING/ROOF DECK	16d @ 12" o.c.	NOTE 2
BLOCKING/METAL ROOF DECK	SCREWS @ 12" o.c.	_
BLOCKING/BLOCKING (PERPENDICULAR)	A34 @ 12" o.c.	NOTE 1
BLOCKING/BLOCKING (PARALLEL)	16d @ 12" o.c.	NOTE 2
BLOCKING/BLOCKING (STACKED)	TP35 @ 16" o.c.	NOTE 1
BLOCKING/STEEL BEAM	1/2"ø BOLTS @ 4' o.c.	_
BLOCKING/CONCRETE WALL	CONC. FASTENERS @ 16" o.c.	NOTE 2
CHAMFERED BLOCK/BLOCKING	16d @ 12" o.c.	NOTE 2
ROOF SHEATHING (PLYWOOD)	NOTE 4	NOTE 4
ROOF SHEATHING (DECKING)	NOTE 4	NOTE 4
FASCIA/FASCIA NAILER	16d @ 12" o.c.	NOTE 2
FASCIA/RAFTER END	(2) 16d PER RAFTER	NOTE 2


(1) FOR A34 AND TP 35 PLATES, USE SIMPSON N8 NAILS OR #8 X 1:

(2) USE FULL LENGTH COMMON WIRE NAILS.

(3) REFER TO PROJECT SPECIFICATIONS FOR DETAILED MATERIAL AND

(4) REFER TO STRUCTURAL DRAWINGS FOR ROOF DECK REPLACEMENT.


TYPICAL FASTENER SCHEDULE

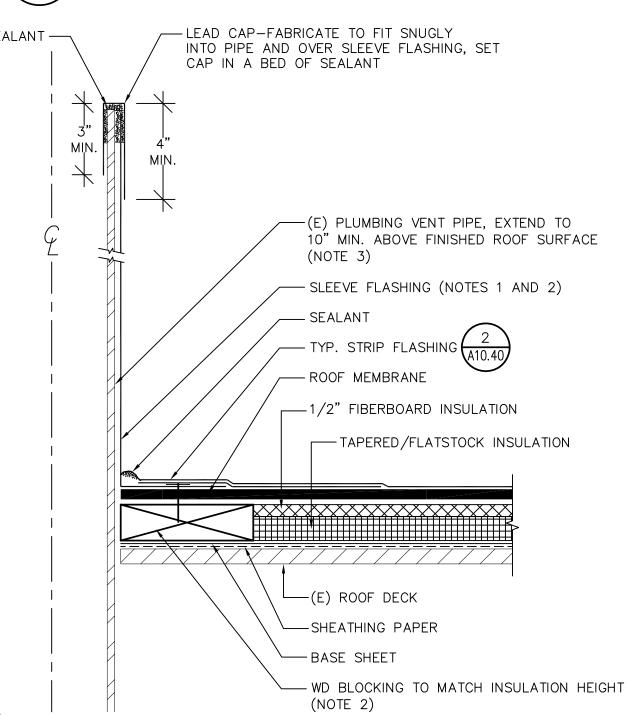


(1) IF (E) FLANGE DOES NOT SATISFY THE DIMENSION LISTED IN THE FLANGE SCHEDULE ON DETAIL 2/A10.40, MECHANICALLY FASTEN AND SOLDER ADDITIONAL PIECE OF SHEET METAL TO ACHIEVE DIMENSION LISTED IN

(2) WOOD BLOCKING AND FLANGE NAILING MAY BE OMITTED IF LEAD SLEEVE FLASHING IS USED. (3) EXTEND PIPE USING NO-HUB CONNECTION BELOW ROOF DECK.


VENT PIPE A10.40 SCALE: NOT TO SCALE

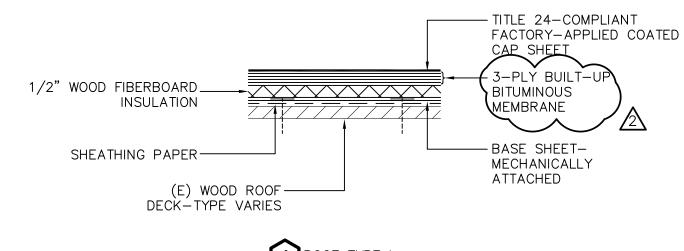


ROOF TYPE I

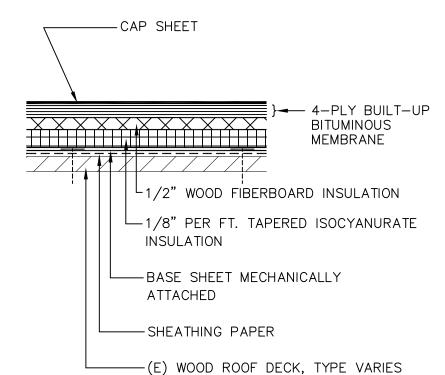

2 ROOF TYPE II

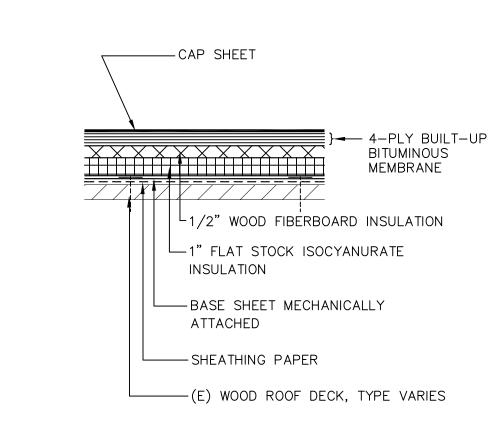


3 ROOF TYPE III

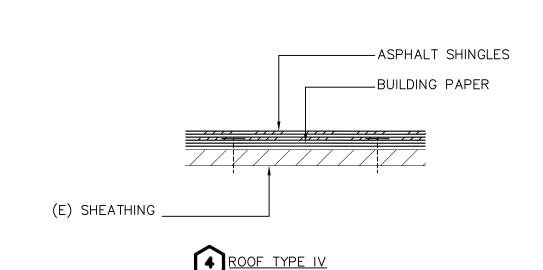

(1) ROOF TYPES I - III ARE CLASS A FIRE RATED (UL TGFU.RB06). (2) ROOF TYPE IV IS CLASS A FIRE RATED (UL TFWZ.R4299 AND TGDY.R21900).

ROOF ASSEMBLY A10.40 SCALE: NOT TO SCALE

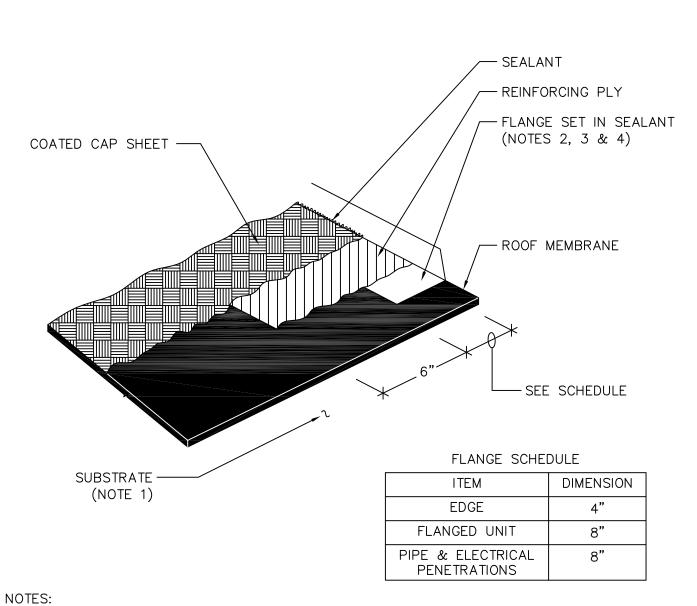

(1) REFER TO ROOF PLANS FOR SUBSTRATE TYPE.

(2) FLANGE NAILING IS NOT SHOWN FOR CLARITY. (3) APPLY PRIMER TO TOP AND BOTTOM AND SET IN SEALANT. (4) FASTENERS AT 3" O.C.

TYPICAL STRIP FLASHING A10.40 SCALE: NOT TO SCALE

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REF OR \simeq

2	12/13/22	ADDENDUM 2		
$\overline{\Lambda}$	12/5/22	ADDENDUM 1		
	3/16/22	F	REVIEW SET	E
۱0.	DATE	D	ESCRIPTION	В
PROJECT NO.		21043		
CAD	D FILE			
DESIGNED BY		AEB		
DRAWN BY		EY		
CHE	CKED BY			
DATE		15 OCT 2021		
DRAWING SCALE		AS NOTED		

ROOF REPLACEMENT DETAILS

SHEET TITLE

DRAWING NO.

A10.40

OF